




SITE LEGEND	
	PROPERTY LINE
	RIGHT-OF-WAY LINE
	SUBLOT LINE
	EASEMENT LINE
	BUFFER LINE
	CENTERLINE
	STREAM BUFFER
TS T	POTENTIAL GREEN AREA /OPEN SPACE

HIGH STREET DISTRICT DEVELOPN 1422 S TRYON STREET, SUITE 200 CHARLOTTE, NORTH CAROLINA 28	,
PARCEL NUMBER: 05109108 & 05109105	
TOTAL SITE ACREAGE:	± 32.35 AC
EXISTING ZONING:	N1-A
PROPOSED ZONING:	N2-A (CD)
PROPOSED USE:	MULTI-DWELLING DEVELOPMENT WHICH MAY INCLUDE A COMBINATION OF DUPLEX, TRIPLEX, QUADRAPLEX AND/OR MULTI-FAMILY ATTACHED DWELLINGS
PERIMETER BUILDING SETBACK REQUIREMENT	-S:
REAR:	20'
SIDE:	5'
MAXIMUM BUILDING HEIGHT:	PER ORDINANCE
PARKING:	PER ORDINANCE
INTERNAL SETBACK REQUIREMENTS:	
FRONT:	20' FROM FUTURE BACK OF CURB
TOTAL DWELLING COUNT:	UP TO 190 DWELLINGS
REQUIRED OPEN SPACE:	PER ORDINANCE
REQUIRED GREEN AREA (15% OF SITE):	± 4.85 AC
PROVIDED GREEN AREA:	± 4.85 AC
STORMWATER MANAGEMENT:	± 1.28 AC
	······································
FINAL SITE LAYOUT AND PRODUCT TYPE 2. ONSITE GARBAGE AND RECYCLE REQUIR 3. PROPERTY LINES PROVIDED ON REZONII SURVEY CONDUCTED BY MCADAMS. WHI	EMENTS TO BE MET PER ARTICLE 21. NG PLAN ARE BASED ON DEED RESEARCH AND BOUNDARY LE THERE ARE DIFFERING PROPERTY LINES PER POLARIS, LINES FOLLING THE EXISTING CREEKS CENTERLINES ON TH

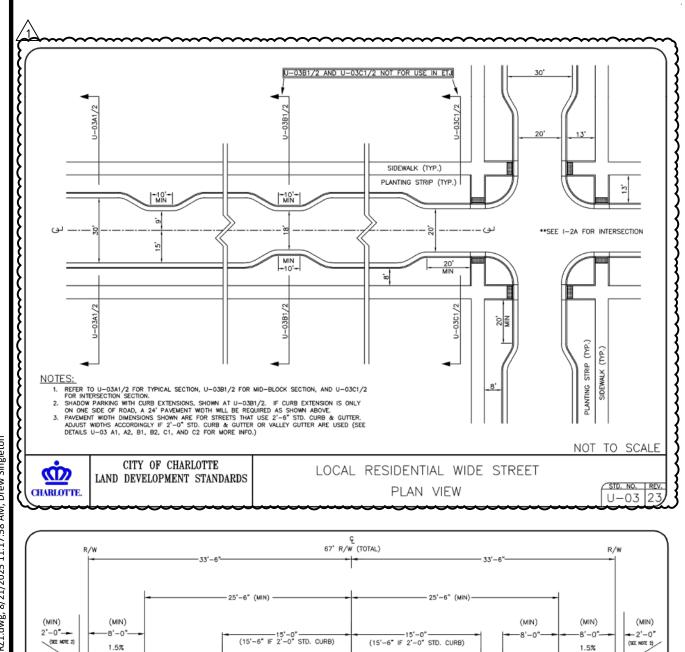

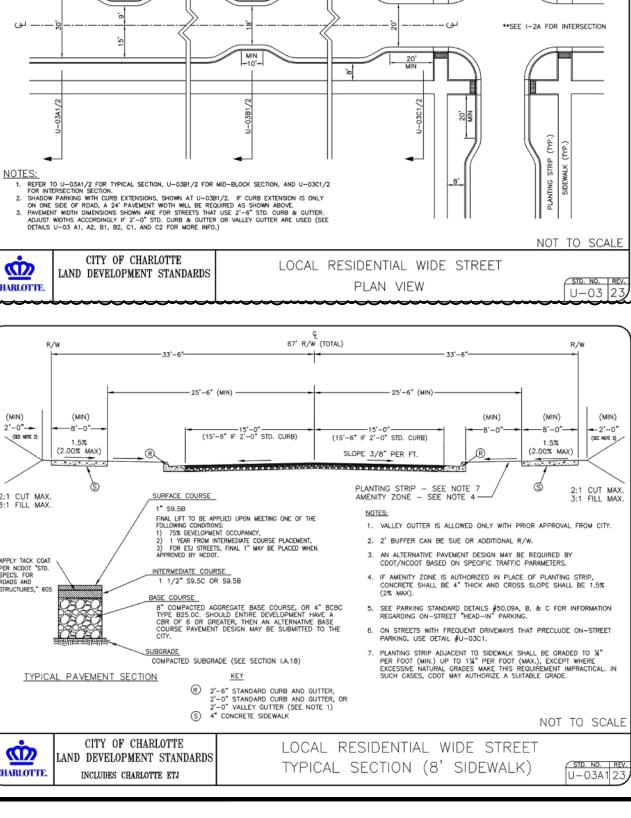

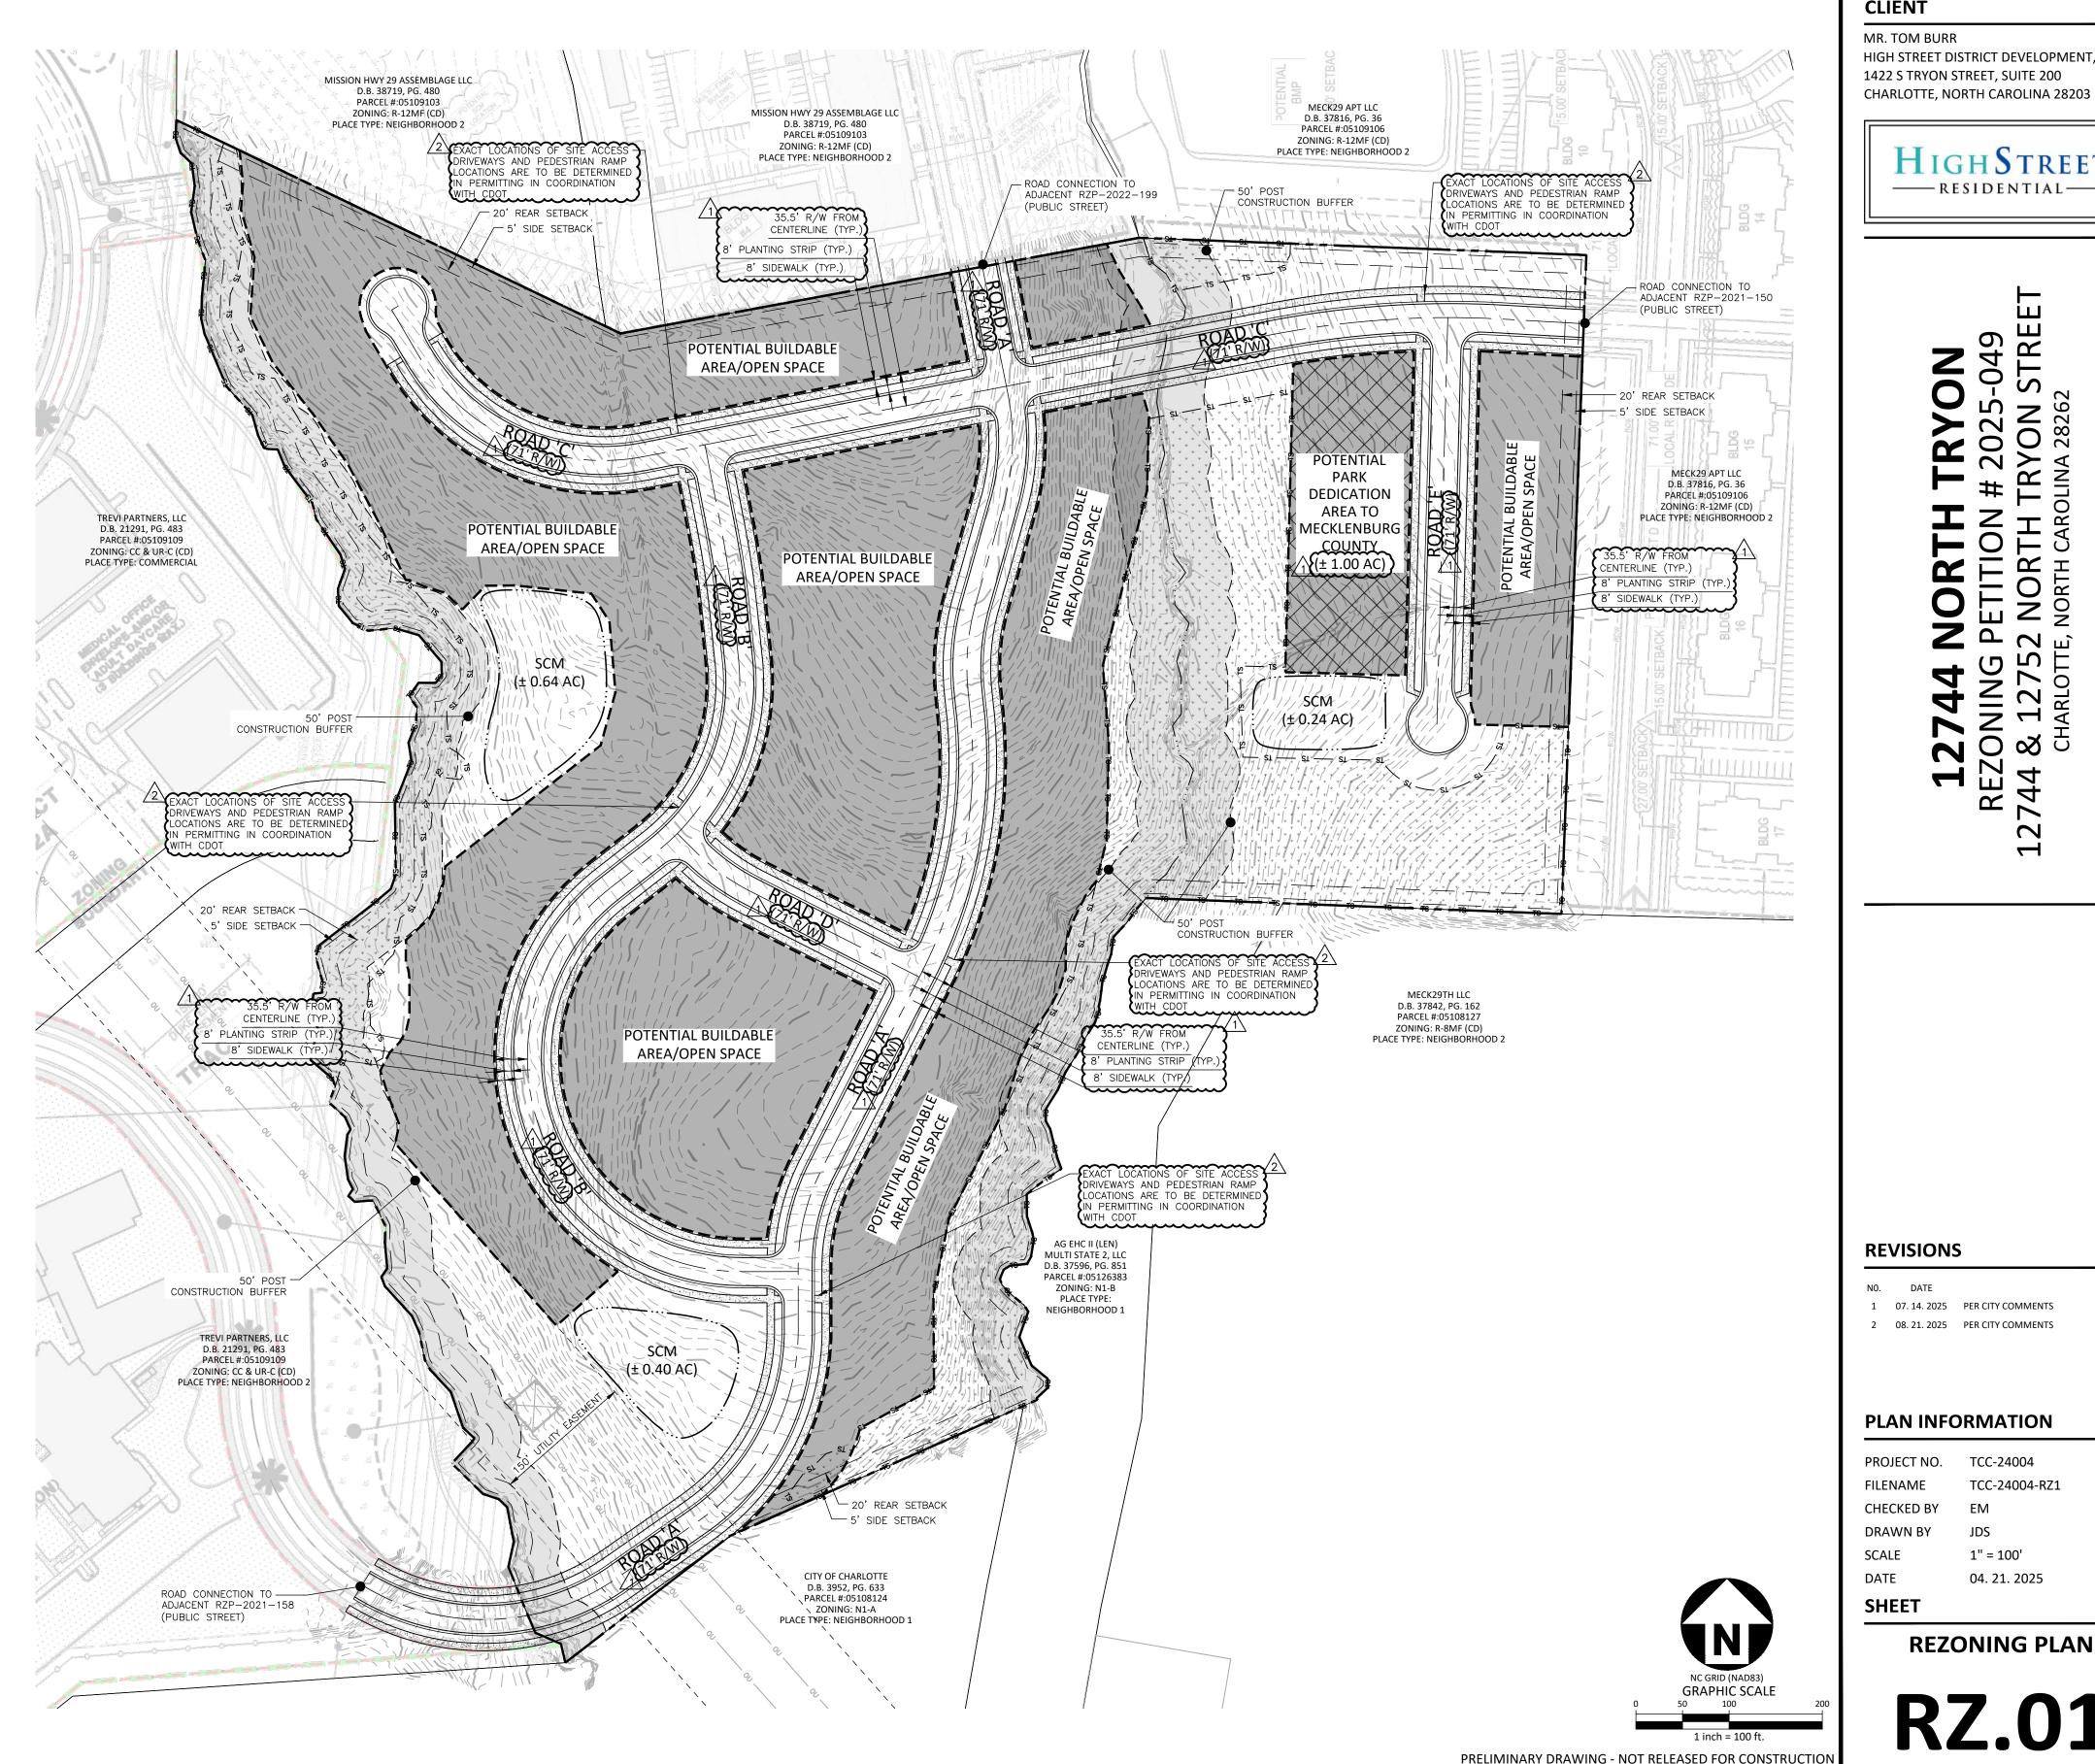



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CLIENT

MR. TOM BURR HIGH STREET DISTRICT DEVELOPMENT, INC. 1422 S TRYON STREET, SUITE 200



REVISIONS

NO. DATE

1 07. 14. 2025 PER CITY COMMENTS 2 08. 21. 2025 PER CITY COMMENTS

PLAN INFORMATION

PROJECT NO. TCC-24004 TCC-24004-RZ1 FILENAME CHECKED BY DRAWN BY SCALE 1" = 100'

DATE 04. 21. 2025 SHEET

REZONING PLAN

High Street District Development, Inc. 12744 & 12752 North Tryon Street Development Standards 8/21/25/2

Rezoning Petition 2025-049

Site Development Data:

--Acreage: ± 32.35 AC
--Tax Parcel #: 05109108 & 05109105
--Existing Zoning: N1-A
--Proposed Zoning: N2-A(CD)

--Existing Uses: Single family residential

--Proposed Uses: A multi-dwelling development with up to one hundred and ninety (190) dwelling units which may include a combination of duplex, triplex, quadraplex and/or multi-family attached dwelling units as allowed by right and under prescribed conditions in the N2-A zoning district together with accessory uses as more specifically described below in Section 2.

--Maximum Building Height: Per Ordinance --Parking: Per Ordinance

1. General Provisions:

- **a. Site Location.** These Development Standards, the Technical Data Sheet, Schematic Site Plan and other graphics set forth on attached Sheets form this rezoning plan (collectively referred to as the "Rezoning Plan") associated with the Rezoning Petition filed by High Street District Development, Inc. to accommodate the development of a residential community on an approximately ± 32.35 -acre site located at 12744 & 12752 North Tryon Street, Charlotte NC 28262. (the "Site").
- **b.** Zoning Districts/Ordinance. Development of the Site will be governed by the Rezoning Plan as well as the applicable provisions of the City of Charlotte Unified Development Ordinance (the "Ordinance"). Unless the Rezoning Plan establishes more stringent standards, (i) the regulations established under the Ordinance for the N2-A zoning classification for the portion of the Site so designated on the Rezoning Plan shall govern all development taking place on the Site.
- c. Graphics and Alterations. The schematic depictions of the uses, streets, potential buildable areas and open space, and other development matters and site elements (collectively the "Development/Site Elements") set forth on the Rezoning Plan should be reviewed in conjunction with the provisions of these Development Standards. The layout, locations, sizes, and formulations of the Development/Site Elements depicted on the Rezoning Plan are graphic representations of the Development/Site elements proposed.

Since the project has not undergone the design development and construction phases, it is intended that this Rezoning Plan provide for flexibility in allowing some alterations or modifications from the graphic representations of the Development/Site Elements. Therefore, there may be instances where minor modifications will be allowed without requiring the Administrative Minor Amendment Process per Article 37.3 of the Ordinance. These instances would include changes to graphics if they are minor and don't materially change the overall design intent depicted on the Rezoning Plan.

The Planning Director will determine if such minor modifications are allowed per this amended process, and if it is determined that the alteration does not meet the criteria described above, the Petitioner shall then follow the Administrative Minor Amendment Process per Article 37.3 of the Ordinance; in each instance, however, subject to the Petitioner's appeal rights set forth in the Ordinance.

d. Number of Buildings Principal and Accessory. The total number of principal residential buildings to be developed on the Site shall not exceed sixty (60). Accessory buildings and structures located on the Site shall not be considered in any limitation on the number of buildings on the Site. Accessory buildings and structures will be constructed utilizing similar building materials, colors, architectural elements and designs as the principal buildings located on the Site.

2. Permitted Uses & Development Area Limitation:

a. The Site may be developed with a multi-dwelling development with up to one hundred and ninety (190) dwelling units which may include a combination of duplex, triplex, quadraplex and/or multi-family attached dwelling units as allowed by right and under prescribed conditions in the N2-A zoning district together with accessory uses.

3. Access, and Transportation Improvements:

- **a.** Access to the Site will be from the extensions of existing and proposed public streets which stub to the Site. These include the extension of Trevi Village Boulevard to the west per rezoning petition #2021-158, the extension of Amapala Avenue to the east per rezoning petition #2021-150, and the extension of a future street to the north per rezoning petition #2022-199.
- **b.** The location of future curb and gutter for network required streets will follow CLDSM standard U-03 for local residential wide streets. The internal network required streets will be constructed with an eight (8) foot planting strip and an eight (8) foot sidewalk per the local residential wide cross-section U-03A.
- c. All on-site transportation improvements, if any, shall be constructed and approved prior to the release of the first certificate of occupancy for the Site. The petitioner may phase transportation improvements if said improvements and phasing are explicitly described in site plan notes or agreed to during the land development approval process for the Site. The petitioner may request that CDOT allow a bond to be posted for any improvements not completed at the time the first certificate of occupancy is requested and released.
- **d.** The placement and configuration of the vehicular access point is subject to minor modifications required to accommodate final site development and construction plans and to any adjustments required for approval by the CDOT and NCDOT in accordance with applicable published standards.
- **e.** The alignment of the internal vehicular circulation and driveways may be modified by the Petitioner to accommodate changes in traffic patterns, parking layouts, and any adjustments required for approval by CDOT in accordance with applicable published standards.
- f. All public roadway improvements will be subject to the standards and criteria of CDOT and NCDOT, as applicable, to the roadway improvements within their respective road system authority. It is understood that such improvements may be undertaken by the Petitioner on its own or in conjunction with other development or roadway projects taking place within the broad northeastern Mecklenburg area, by way of a private/public partnership effort or other public sector project support.

- g. The Site is located outside the Charlotte City limits. However, the petitioner intends to file for voluntary annexation into the Charlotte City limits. The Petitioner reserves the right to make additional adjustments that may be necessary to accommodate changes throughout the permitting and construction process as approved by NCDOT/CDOT based on the jurisdiction in which the Site is located.
- h. In the event a Right-of-Way Encroachment Agreement is necessary for the installation of any non-standard item(s) (irrigation systems, decorative concrete pavement, brick pavers, etc.) within a proposed/existing City maintained street right-of-way by a private individual, group, business, or homeowner's/business association, an encroachment agreement will be submitted for approval by CDOT prior to construction/installation.

i. Pedestrian ramps will be provided at street intersections in coordination with CDOT.

The exact locations of site access driveways and pedestrian ramp locations are to be determined in permitting in coordination with CDOT

j. The Petitioner shall dedicate and convey in fee simple all rights-of-way to the City before the site's first building certificate of occupancy is issued for network required public streets. Additional right-of-way set at 2' behind back of sidewalk will be provided where feasible for a total right of way width of 71' for the local residential wide public streets. The determination on whether network required streets are to be public or private will be made during the land development review process.

4. Setbacks, Open Space, Park Dedication and Landscaping:

- **a.** A twenty (20) foot front setback will be provided along all the new internal network required local streets as measured from the future back of curb.
- **b.** Side and rear yards will be provided as required by Ordinance.
- c. Open space will be provided per the N2-A requirements found in Article 5.4. In areas where common open space is provided, such areas may be amenitized with usable outdoor hardscape features, such as courtyards, seating areas, and include various landscape features, such as grass, groundcover, trees, and shrubs. Common open space areas will contain seating options that include a minimum of one bench per 4,000 square feet of common open space and enhanced planting to include a minimum of 18 trees per one acre of common open space. More detail is provided in note 4.h below for public open space.
- d. The Petitioner shall dedicate and convey a minimum of one (1) acre of the land on the corner of Road C and Road E as generally depicted on the Rezoning Plan to Mecklenburg County prior to the issuance of the first CO. The proposed dedicated land shall be used as an option to meet the required on-site open space.
- **e.** If large waste containers and recycling station spaces are provided, they shall be located a minimum of twenty-five (25) feet from a Neighborhood 1 Place Type, Neighborhood 2 Place Type, or network required street.
- **f.** If alleys are provided within the development, supplemental trees will be placed between the buildings along the alley.
- **g.** If required, landscape yards will be provided as required by Article 20.9 of the Ordinance.
- h. Public open space shall consist of four (4) or more of the following potential components which will be committed to as the plans are finalized during the land
- 1. Enhanced plantings in excess of minimum planting standards required of the ordinance (this may be enhanced landscape yards, tree save, etc.). Enhanced plantings may also take the form of trees and/or planting beds (standard, raised and/or terraced with native species). Enhanced planting will include a minimum of 18 trees per one acre of common and public area grass.
- 2. Specialty paving materials (not including standard finished concrete or asphalt). Primary or accent building materials may be used as specialty paver options. Alternate concrete finishing (etching, salt curing, board forming, etc.) is acceptable.
- 3. Shading elements such as shade structures or additional trees planted in a manner to provide consistent shade in the space.
- 4. Seating options that include moveable tables and chairs. Other seating elements to be considered include seating walls, swings or interactive furniture, and immovable benches. Seating requirements for publicly accessible open space shall be provided at 1 linear foot of seating per 300 square feet of public open space. Seating shall be a mixture of moveable and fixed
- . Have a minimum dimension of 50 feet or more measured in all directions.
- 6. Public art/sculpture. Public art, either in the form of murals, sculpture, or other mediums alongside the details of the art intervention (inclusive of type, size, and location) shall be provided during land development review. The petitioner may use the City of Charlotte's Creative Artist Pool to utilize for implementing any public art.
- 7. Interactive elements that users the enjoyment of sensory stimulation. These elements should include but not be limited to music, water, and light and play.
- 8. Decorative lighting elements that include uplighting of trees or other open space elements and additional ambient lighting elements to enhance the experience of the space. When this element is utilized, the petitioner shall provide a lighting plan to plan review staff that provides details/technical notes on the element along with the location of installation.
- 9. At least one common open space area shall be accessible from all residential lots in the residential development within a 1,000-foot radius of the common open space area. This radius is measured in a straight line from the lot line, without regard for street, sidewalk or trail connections, to the nearest point of the open space. Multiple common open space areas may be needed to meet this requirement.

5. **General Design Guidelines:**

development permitting process:

- **a.** The residential buildings on the Site will comply with the applicable residential site layout, building design standards, and building material restrictions found in Article 5 of the Ordinance. Accessory buildings and structures associated with the multi-dwelling development will be constructed utilizing similar building materials, colors, architectural elements, and designs as the principal building(s) located on the Site.
- b. Windows, doors, porches, stoops, or other architectural features are required on all frontage-facing facades to avoid the appearance of blank walls. All ground floor entrances to individual units on a frontage with a sidewalk shall be between 1' and 5' above or below the grade of the adjacent sidewalk when located within 10' of the back of sidewalk. If porches are provided, they shall be covered and be at least five (5) feet depth. If stoops are provided, they shall be at least three (3) feet deep and may be covered.
- c. The facades of the buildings abutting public streets and internal network required streets will not have blank walls that exceed twenty (20) feet in length on all building levels. Windows will be provided on these facades abutting public streets and internal network required streets in order to accommodate a minimum 25% transparency on the ground floor

- and 15% transparency on the upper floors to avoid blank walls. When a building abuts both a frontage and common open space and the building fronts along the common open space as permitted per Article 5.3.G, these design standards will also apply to the facades of the buildings fronting the common open space.
- **d.** Roof form and rooflines shall be designed to avoid the appearance of a large monolithic roof structure as follows: (i) Long pitched or flat roof lines shall avoid continuous expanses without variation by including changes in height and/or roof form, to include but not be limited to gables, hips, dormer or parapets; and (ii) For pitched roofs the minimum allowed is 5:12 excluding buildings with a flat roof and parapet walls.
- **e.** Meter banks, HVAC, and related mechanical equipment will be screened as required per the Ordinance. Ground-mounted or wall-mounted mechanical equipment shall not be located in the established setbacks along a frontage.
- f. If dumpster and recycling areas are provided, will be fully enclosed on three sides by a minimum 75% opaque fence with one side being a decorative gate. The fence used to enclose the dumpster will be of a material prescribed by the Ordinance and be of a compatible color used on the principal buildings.
- g. All dwelling units will have garages. Residential buildings with front loaded garages will include a minimum 20' long parking pad. On-street parking will be provided along the local residential wide network required streets abutting open space areas, dedicated park area, and residential buildings with rear loaded garages. Such on-street parking will provide visitor parking and additional parking options for residents.
- **h.** Walkways shall be provided to connect all residential entrances to sidewalks along abutting streets. For dwelling units which front along a network required street, a direct pedestrian connection will be provided from the entrance to the adjacent public sidewalk.
- i. A minimum of 50% of the residential buildings within the multi-dwelling development will contain four (4) or less dwelling units. No residential building may contain more than (six (6) dwelling units, and such buildings are limited to no more than 10% of all residential buildings. Residential buildings fronting public or private network required streets are limited to five (5) or less dwelling units.

6. Environmental Features:

- a. The Petitioner shall comply with the Charlotte City Council approved and adopted Unified Development Ordinance, Stormwater Articles 23 through 28. The location, size, and type of storm water management systems that may be depicted on the Rezoning Plan are subject to review and approval as part of the full development plan submittal and are not implicitly approved with this rezoning. Adjustments may be necessary in order to accommodate actual storm water treatment requirements and natural site discharge points.
- **b.** The Site will comply with the Tree provisions of the Ordinance found in Article 20. Any tree save areas depicted on the Rezoning Plan to meet the Green Area requirements of this Article are subject to review and approval as part of the full development plan submittal and are not implicitly approved with this rezoning petition and are subject to change.
- **c.** Development within any SWIM/PCSO Buffers shall be coordinated with and subject to approval by Charlotte-Mecklenburg Storm Water Services and mitigated if required by Ordinance. Stream delineation reports are subject to review and approval by Charlotte Storm Water Services.

7. <u>Lighting</u>:

a. All freestanding exterior lighting installed on the Site shall comply with Article 16.2 of the Ordinance.

8. Amendments to the Rezoning Plan:

a. Future amendments to the Rezoning Plan (which includes these Development Standards) may be applied for by the then Owner or Owners of the applicable development area or portion of the Site affected by such amendment in accordance with the provisions herein and of Article 37.3 of the Ordinance.

9. <u>Binding Effect of the Rezoning Application</u>:

a. If this Rezoning Petition is approved, all conditions applicable to the development of the Site imposed under the Rezoning Plan will, unless amended in the manner provided under the Ordinance, be binding upon and inure to the benefit of the Petitioner and subsequent owners of the Site and their respective heirs, devisees, personal representatives, successors in interest or assigns.

MULTIMODEL ASSESSMENT

Land Line (ITE Code)	Density Calculation	Daily	AM Peak Hour			PM Peak Hour			
Land Use (ITE Code)	Density	Methodology	Trips	Enter	Exit	Total	Enter	Exit	Total
Multifamily Housing -Low Rise (220)	190 units	Adjacent / Equation	1,293	20	62	82	64	38	102
		Total External Trips	1,293	20	62	82	64	38	102


TABLE 2: MULTIMODAL ASSESSMENT MITIGATION OPTIONS	
Mitigation Method	Mitigation Points
Intersections & Accessible Ramps	
Construct or reconstruct 2 accessible ramps (unsignalized intersections)	1

Summary / Recommendations

A Tier 1 MA providing 3 mitigation points is required based on the proposed trip generation potential and the proposed N2-A zoning of the site. The MA mitigation points are achieved by the following:

MA Mitigation Methods:

• Construct or reconstruct 6 accessible ramps on Caprington Avenue at Oakton Hunt Drive or Wayhill Drive at Oldehurst Place or any identified location in the figure based on accessibility of ROW and ease of constructability (3 points).

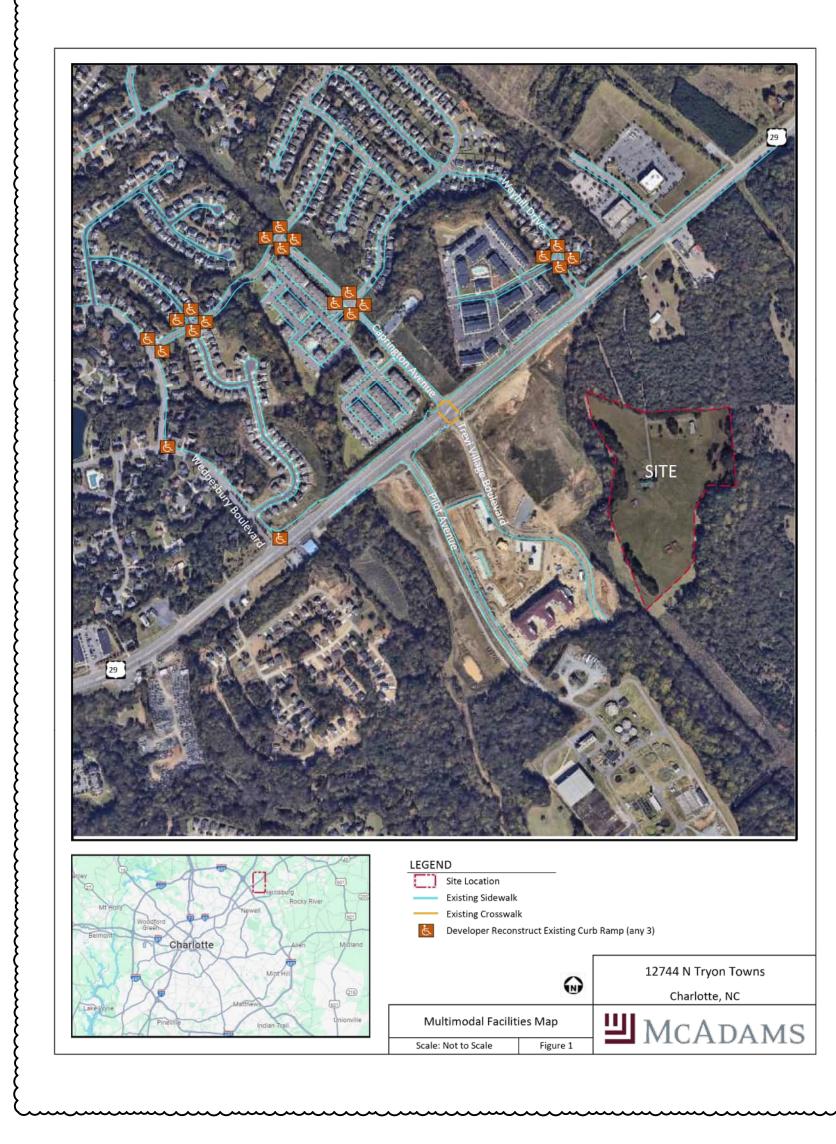

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REZONING PETITION # 2025-049
2744 & 12752 NORTH TRYON STRE

REVISIONS

NO. DATE

07. 14. 2025 PER CITY COMMENTS
 08. 21. 2025 PER CITY COMMENTS

PLAN INFORMATION

PROJECT NO. TCC-24004
FILENAME TCC-24004-RZ1
CHECKED BY EM

DRAWN BY SCALE DATE


SHEET

PRELIMINARY DRAWING - NOT RELEASED FOR CONSTRUCTION

REZONING NOTES

RZ.02


04. 21. 2025

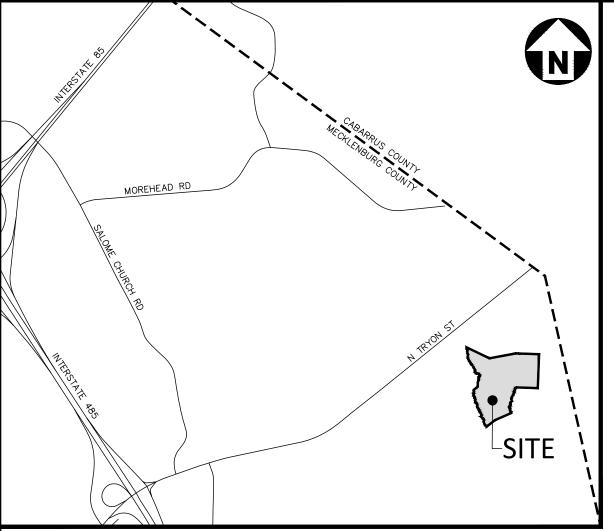

SITE LEGEND	
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	SUBLOT LINE
	EASEMENT LINE
	BUFFER LINE
	CENTERLINE
	STREAM BUFFER
TS T	POTENTIAL GREEN AI /OPEN SPACE

S	ITE DATA
DEVELOPER: MR. TOM BURR HIGH STREET DISTRICT DEVELOF 1422 S TRYON STREET, SUITE 20 CHARLOTTE, NORTH CAROLINA	PMENT, INC.
PARCEL NUMBER: 05109108 & 05109105	
TOTAL SITE ACREAGE:	± 32.35 AC
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PROPOSED ZONING:	N2-A (CD)
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TOTAL DWELLING COUNT:	UP TO 190 DWELLINGS
DECLURED OPEN COACE	PER ORDINANCE
REQUIRED OPEN SPACE:	PER ORDINANCE
	I
REQUIRED GREEN AREA (15% OF SITE):	± 4.85 AC
PROVIDED GREEN AREA:	± 4.85 AC

TREE CHART				TREE CHA	\RT
Tree #	Trunk Dia.	Species	Tree #	Trunk Dia.	Species
1	47"	HARDWOOD	76	23"	OAK
2	37"	POPLAR	77	24"	HICKOR
3	33"	POPLAR	78	25"	GUM
4	38"	POPLAR	79	27"	GUM
5	39"	HARDWOOD	80	25"	OAK
6	35"	HARDWOOD	81	28"	GUM
7	32"	HARDWOOD	82	21"	OAK
8	30"	POPLAR	83	21"	GUM
9	42"	GUM	84	21"	GUM
10	30"	OAK	85	31"	GUM
11	35"	OAK	86	21"	POPLA
12	37"	POPLAR	87	27"	POPLA
13	30"	POPLAR	88	21"	POPLA
14	39"	POPLAR	89	28"	POPLA
15	35"	OAK	90	26"	OAK
16	31"	OAK	91	22"	OAK
17	35"	POPLAR	92	26"	POPLA
18	33"	OAK	93	27"	OAK
19	31"	OAK	94	21"	OAK
20	57"	OAK	95	28"	OAK
21	33"	HARDWOOD	96	28"	OAK
22	30"	HARDWOOD	97	24"	OAK
23	38"	OAK	98	27"	POPLA
24	30"	POPLAR	99	24"	PINE
25	31"	OAK	100	22"	PINE
26	33"	HARDWOOD	101	29"	POPLA
27	41"	POPLAR	102	24"	POPLA
28	31"	POPLAR	103	26"	OAK
29	34"	HARDWOOD	104	28"	POPLA
30	33"	HARDWOOD	105	26"	OAK
31	32"	OAK	106	23"	OAK
32	21"	PINE	107	24"	POPLA
33	24"	GUM	108	26"	POPLA
34	23"	OAK	109	23"	OAK
35	22"	OAK	110	29"	OAK
36	23"	GUM	111	20"	POPLA
37	21"	GUM	112	23"	POPLA
38	20"	GUM	113	28"	POPLA
39	23"	GUM	114	21"	POPLA
40	29"	OAK	115	24"	PINE
41	25"	OAK	116	20"	PINE
42	22"	GUM	117	20"	OAK
43	26"	OAK			
44	26"	GUM			
45	22"	GUM			
46	25"	GUM			
47	21"	GUM			
40	20"	CLIM			

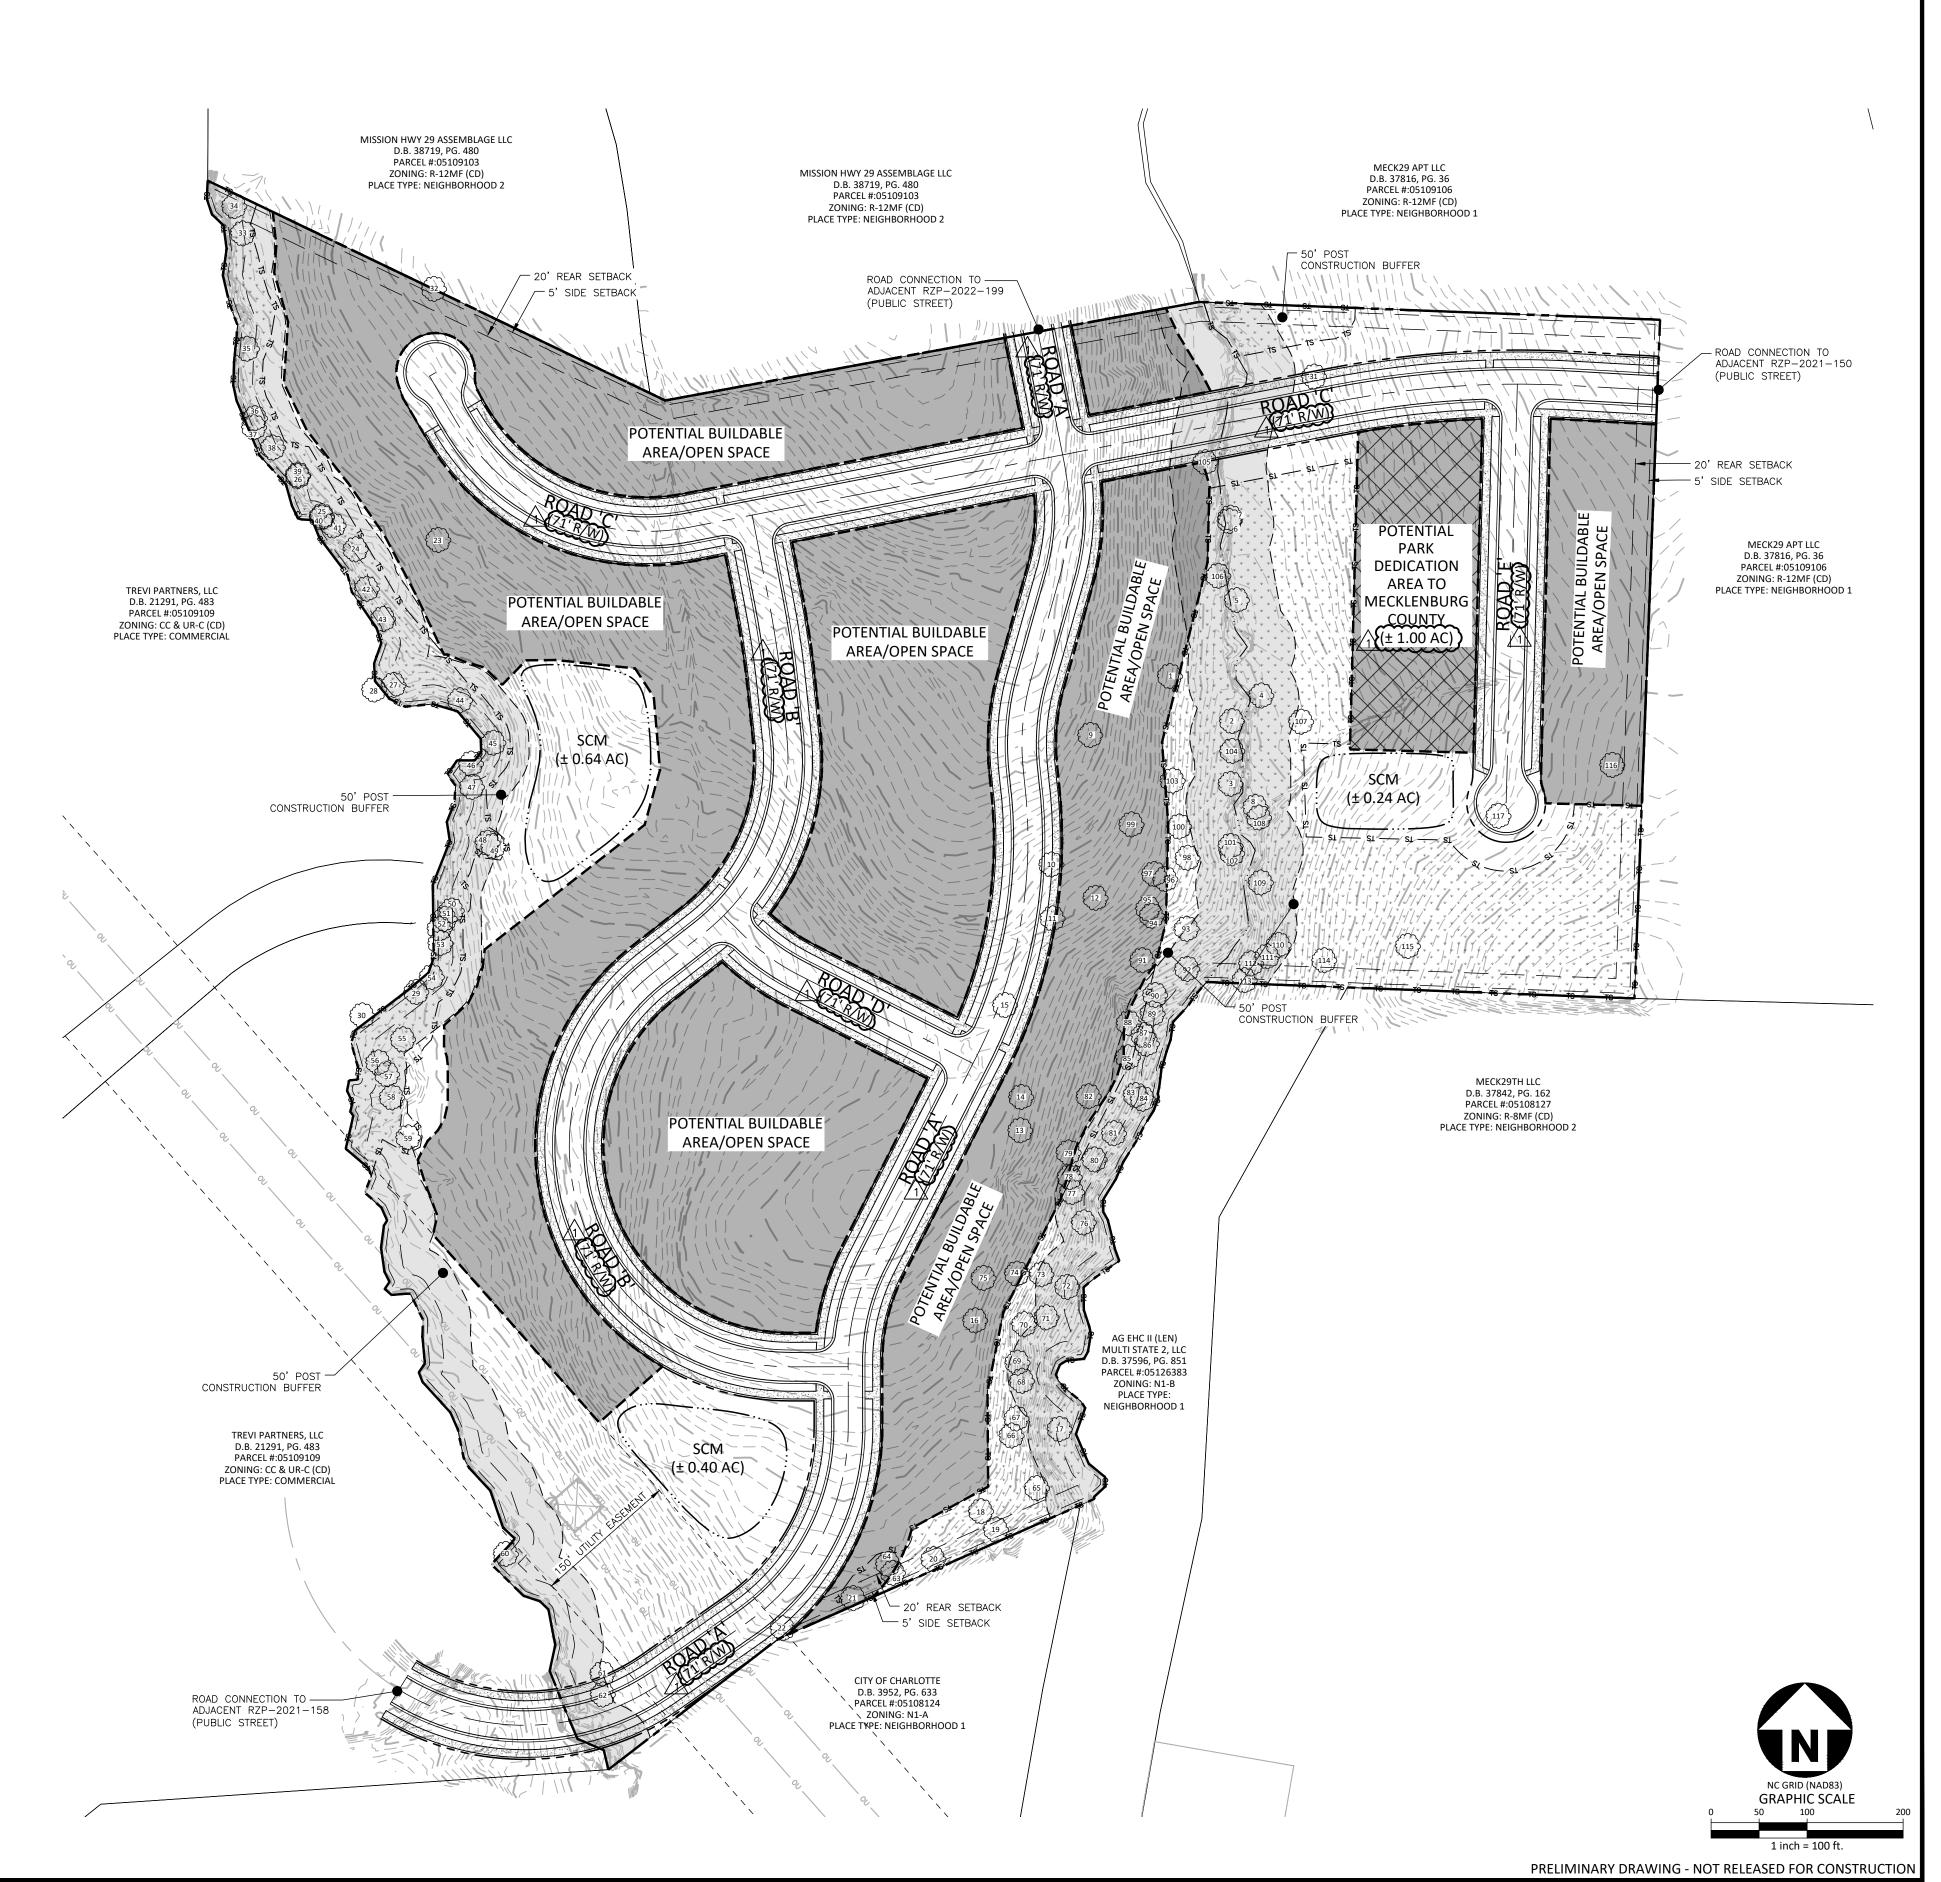



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PLAN INFORMATION

PROJECT NO. TCC-24004

FILENAME TCC-24004-RZ1

CHECKED BY EM

DRAWN BY JDS

SCALE 1" = 100'

DATE SHEET

TREE SURVEY

04. 21. 2025

RZ.03